LOT SIZE: 7267 SF

PROPOSED SQUARE FOOTAGES :

WOODEN DECKS @ GRADE - SQ.FT.

PATIOS @ GRADE - SQ.FT

CRAWL SPACE - SQ.FT.

BASEMENT(partially finished) - SQ.FT.

1ST FLOOR - SQ.FT.

EXISTING GROSS AREAS:

BASEMENT (EXISTING) - GSF (unfinished)

1ST FLOOR (EXISTING) - GSF

APPLICABLE ORDINANCE: RESIDENTIAL CODE OF NEW YORK AS MODIFIED BY THE VILLAGE OF EAST HAMPTON, NY.

DISTRICT: R-40

LOT COVERAGE & ZONING INFORMATION:

-TOTAL ALLOWABLE COVERAGE (FRONT PATH EXCEMPT)
BASED ON 20% OF 7,267 SQ.FT. + 500 SQ.FT. = 1953.4 SQ.FT.
-TOTAL ALLOWABLE PRIMARY STRUCTURE
BASED ON 10% OF 7,267 SQ.FT. + 1000 SQ.FT. = 1726.7 SQ.FT.

NOT STATED ON SURVEY

HEIGHT ALLOWED: 25' ABOVE MEDIAN GRADE PLANE

HEIGHT PROPOSED:


16'	
Sheet List-07	
STORY	
G001	COVER SHEET
1	GENERAL NOTES
2	CODE SHEET
3	CODE SHEET
4	SITE-PLAN & DATA
5	PLUMBING RISER DIAGRAM
6	Window Schedule
7	Door Schedule
A-01	BASEMENT LEVEL
A-02	1ST FLOOR LEVEL
A-03	2ND FLOOR LEVEL
A-04	ROOF PLAN
A-301	SECTIONS
A-302	SECTIONS
A-201	ELEVATIONS
A-202	ELEVATIONS-2
A-203	ELEVATIONS-3
A-204	ELEVATIONS-4
A-401	Enlarged Kitchen
S-00	BASEMENT STRUCTURALS
S-01	1ST FLOOR STRUCTURALS
S-02	2ND FLOOR STRUCTURALS
S-03	ROOF STRUCTURALS
E-00(G)	ELECTRICAL LAYOUT - GARAGE
E-00(B)	ELECTRICAL LAYOUT - BASEMENT
E-01	ELECTRICAL LAYOUT - 1ST
E-02	ELECTRICAL LAYOUT - 2ND
SP-03	MISC
SP-08	MISC
SP-09	MISC
	· · · · · · · · · · · · · · · · · · ·

## GENERAL LANDSCAPING NOTES:

2' OR 3/8" WHITE PEA GRAVEL
12" COMPACTED GRAVEL SUBSTRATE BASE
GEO-TEXTILE LAYER OVER SOIL
STEEL EDGING @ DRIVEWAY/WALKWAY.
BOUNDARY/PRIVACY FENCE:
GALVANIZED WELDED WIRE MESH
4X4 PRESSURE TREATED WOOD TOP RAIL
HEIGHT 54"



SOUTH WEST PERSPECTIVE VIEW

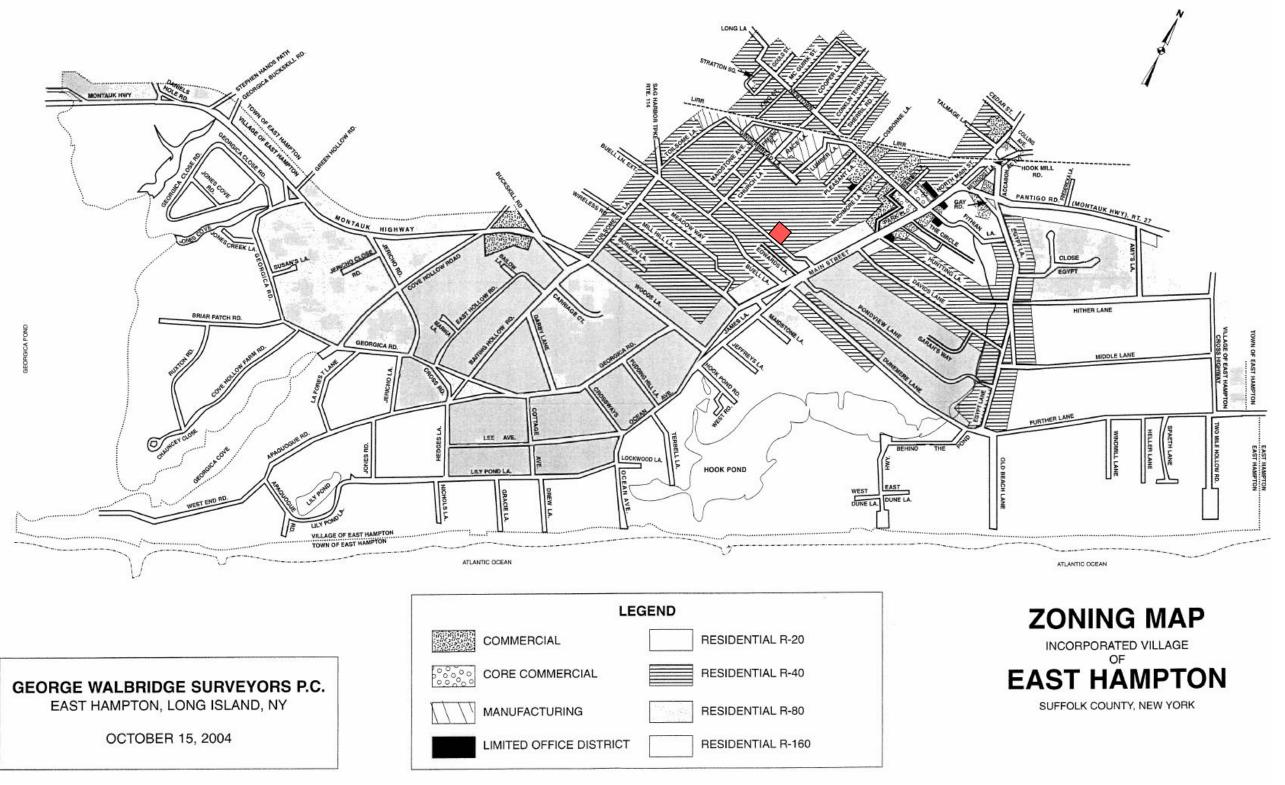

ZONING MAP





LOCUS MAP



SITE SATELLITE VIEW



P2D1 - Design/Build

P. O. Box 1778 Sag Harbor, NY11963 T: 631-494-5300

COPYRIGHT © P2D1 2013

P2D1 - DESIGN/BUILD LLC retains copyright to all material within this document set, including drawings, research, details, etcetera.

All rights reserved. No part of this document set may be used, reproduced, stored in retrieval system, or transmitted in any form or by any means, electronic, mechanical, photocopying or otherwise, without express written consent of P2D1 - DESIGN/BUILD LLC.

Sea

Project: 28 Dayton Lane, East Hampton NY 11937 Pearce Re


Issue Date: Set:


9 JULY 2015

Cover Sheet Title Line 2 Sheet Scale

001

#28 DAYTON LANE

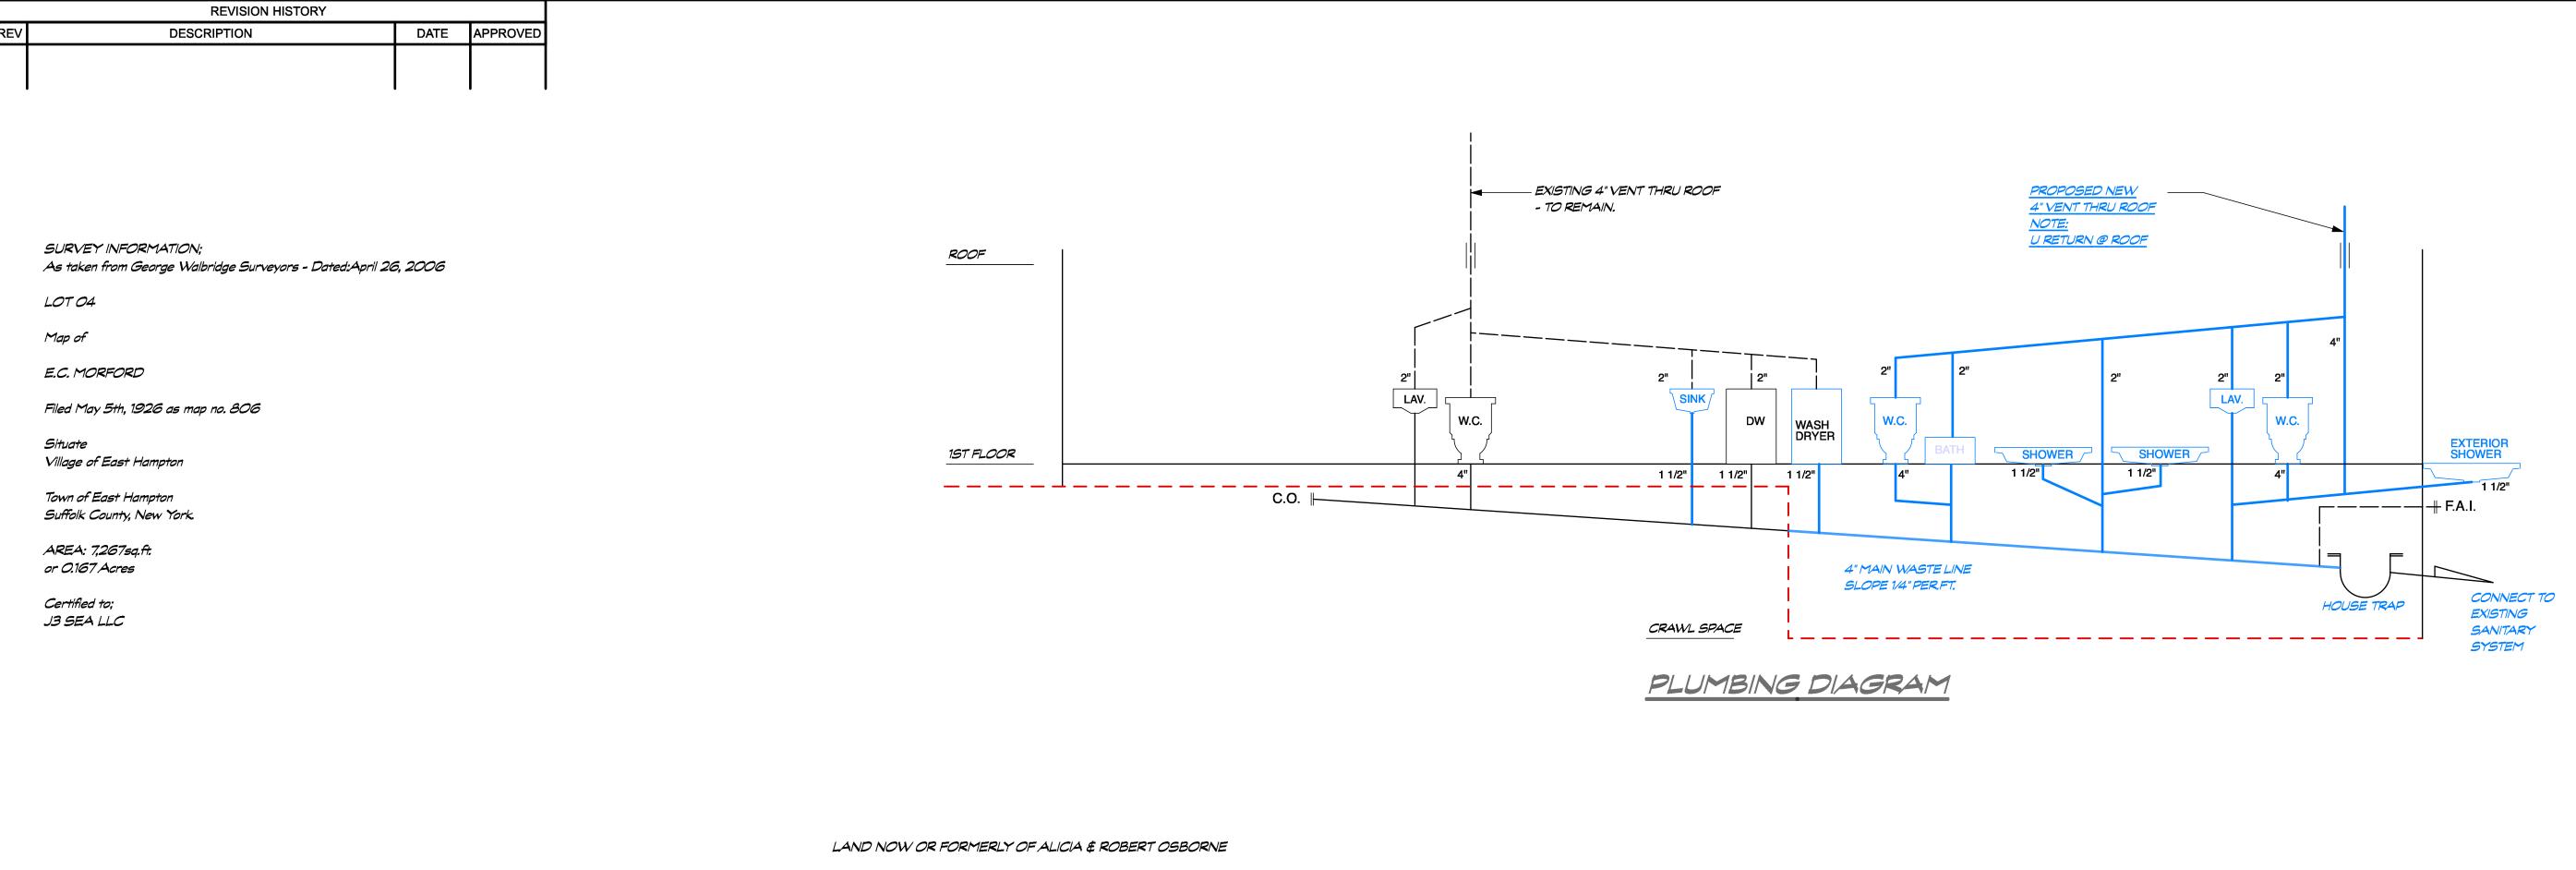

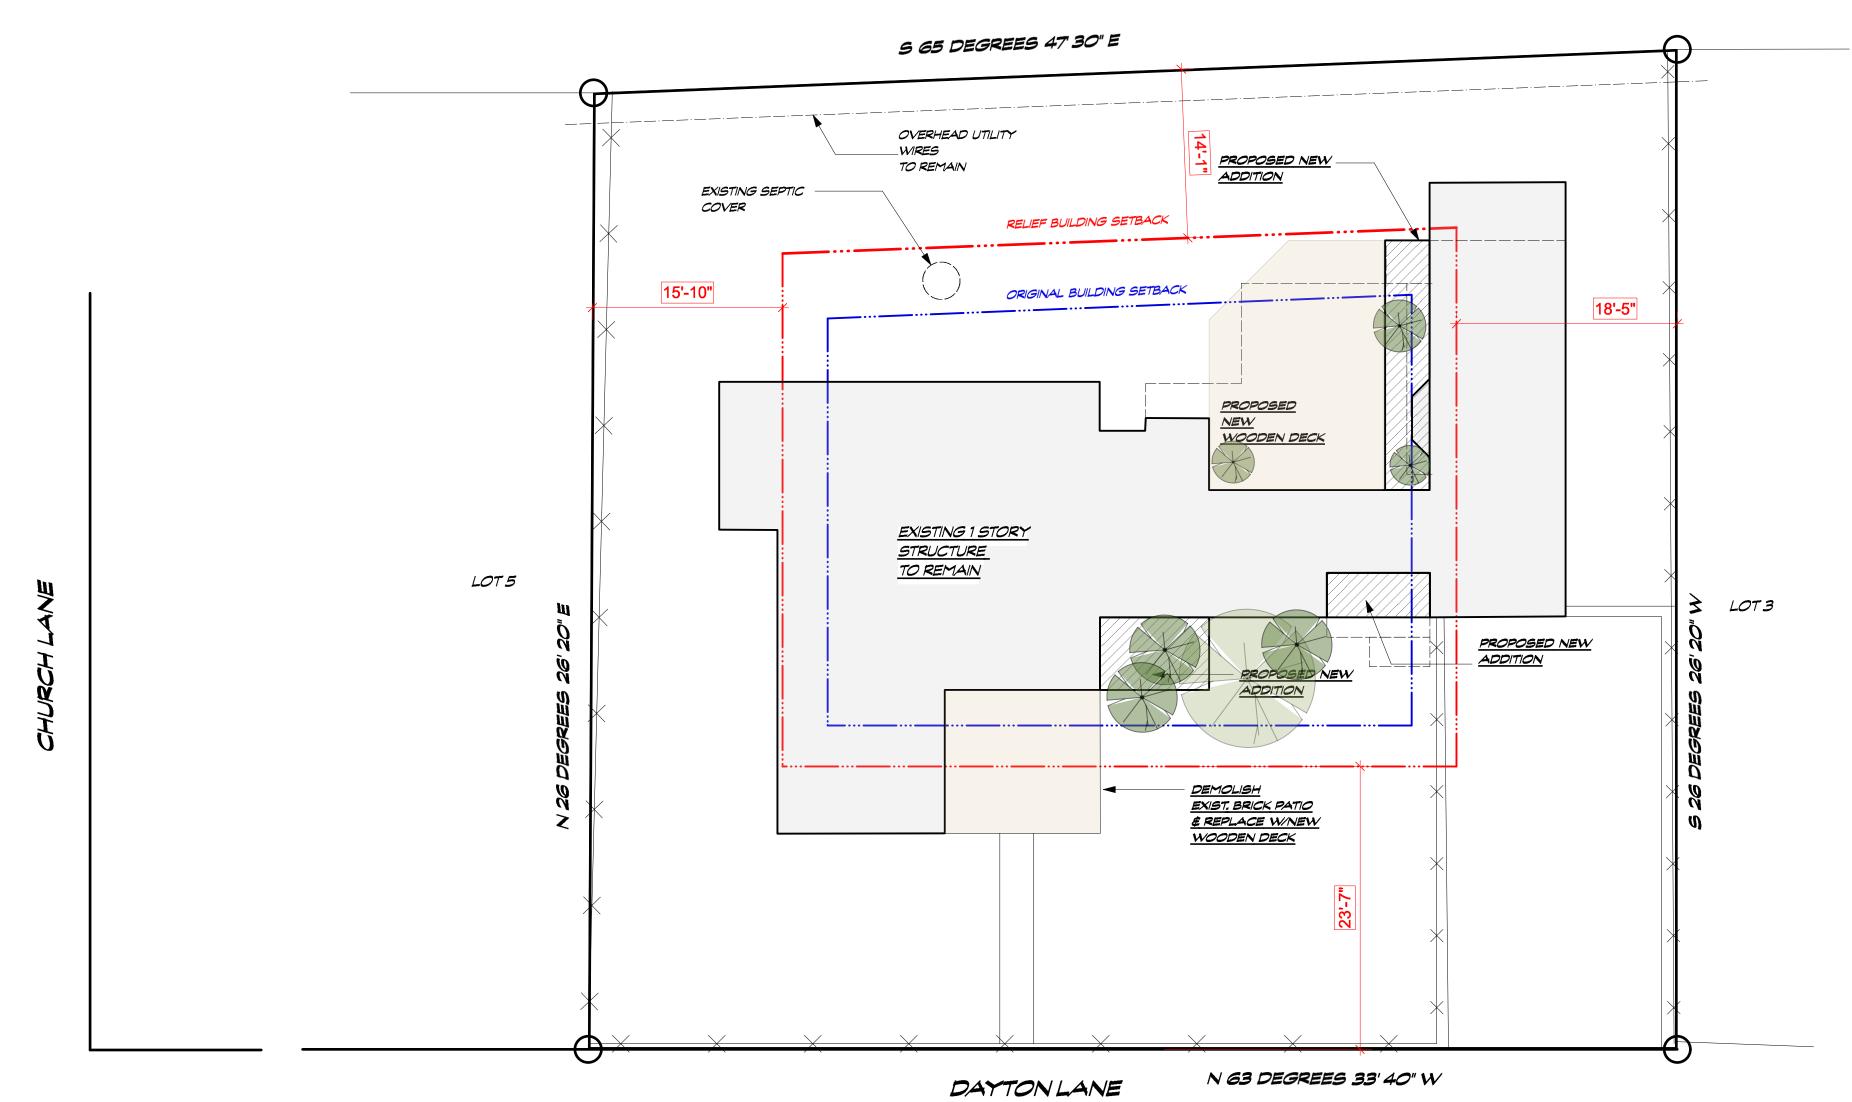

SITE PLAN - SCALE: 1/8" = 1

P2D1 - Design/Build

P. O. Box 1778 Sag Harbor, NY11963 T: 631-494-5300

COPYRIGHT © P2D1 2013
P2D1 - DESIGN/BUILD LLC retains copyright to all material within this document set, including drawings, research, within this document set, including drawings, research, details, etcetera.

All rights reserved. No part of this document set may be used, reproduced, stored in retrieval system, or transmitted in any form or by any means, electronic, mechanical, photocopying or otherwise, without express written consent of P2D1 - DESIGN/BUILD LLC.

Issue Date: Set:

2 JULY 2015

Site Plan Sheet Title Line 2 Sheet Scale

REVISION HISTORY DATE APPROVED DESCRIPTION

EXISTING CONDITIONS/DEMO NOTES:

EXISTING CONDITIONS AND PROPOSED ALTERATIONS HAVE BEEN BASED UPON PHYSICAL INSPECTION AND ASSUMPTION PERTAINING TO AREAS WITH LIMITED ACCESS, NOTIFY ARCHITECT & ENGINEER ONCE DEMOLITION HAS COMMENCED FOR INSPECTION AND MODIFICATION AS REQUIRED,

NEW CONSTRUCTION DATUM:

AGSUME FIRST FLOOR ROUGH ELEVATION @ 00". REFERENCE DATUM ELEVATION TO BE DETERMINED IN FIELD & APPROVED BY ARCHITECT PRIOR TO TRENCHING FOR FOUNDATION FOOTINGS,

NEW FILL/SOIL COMPACTION:


"USE ONLY CLEAN GRANULAR MATERIAL - SAND.

"INDIVIDUAL LIFTS OF MATERIAL NOT TO EXCEED 12" DEEP.

"MINIMUM 95% MECHANICAL COMPACTION.

"WET DOWN AREA OF COMPACTION TO ASSIST WITH MECHANICAL COMPACTION - TYP.

\*AVOID FREEZING CONDITIONS.

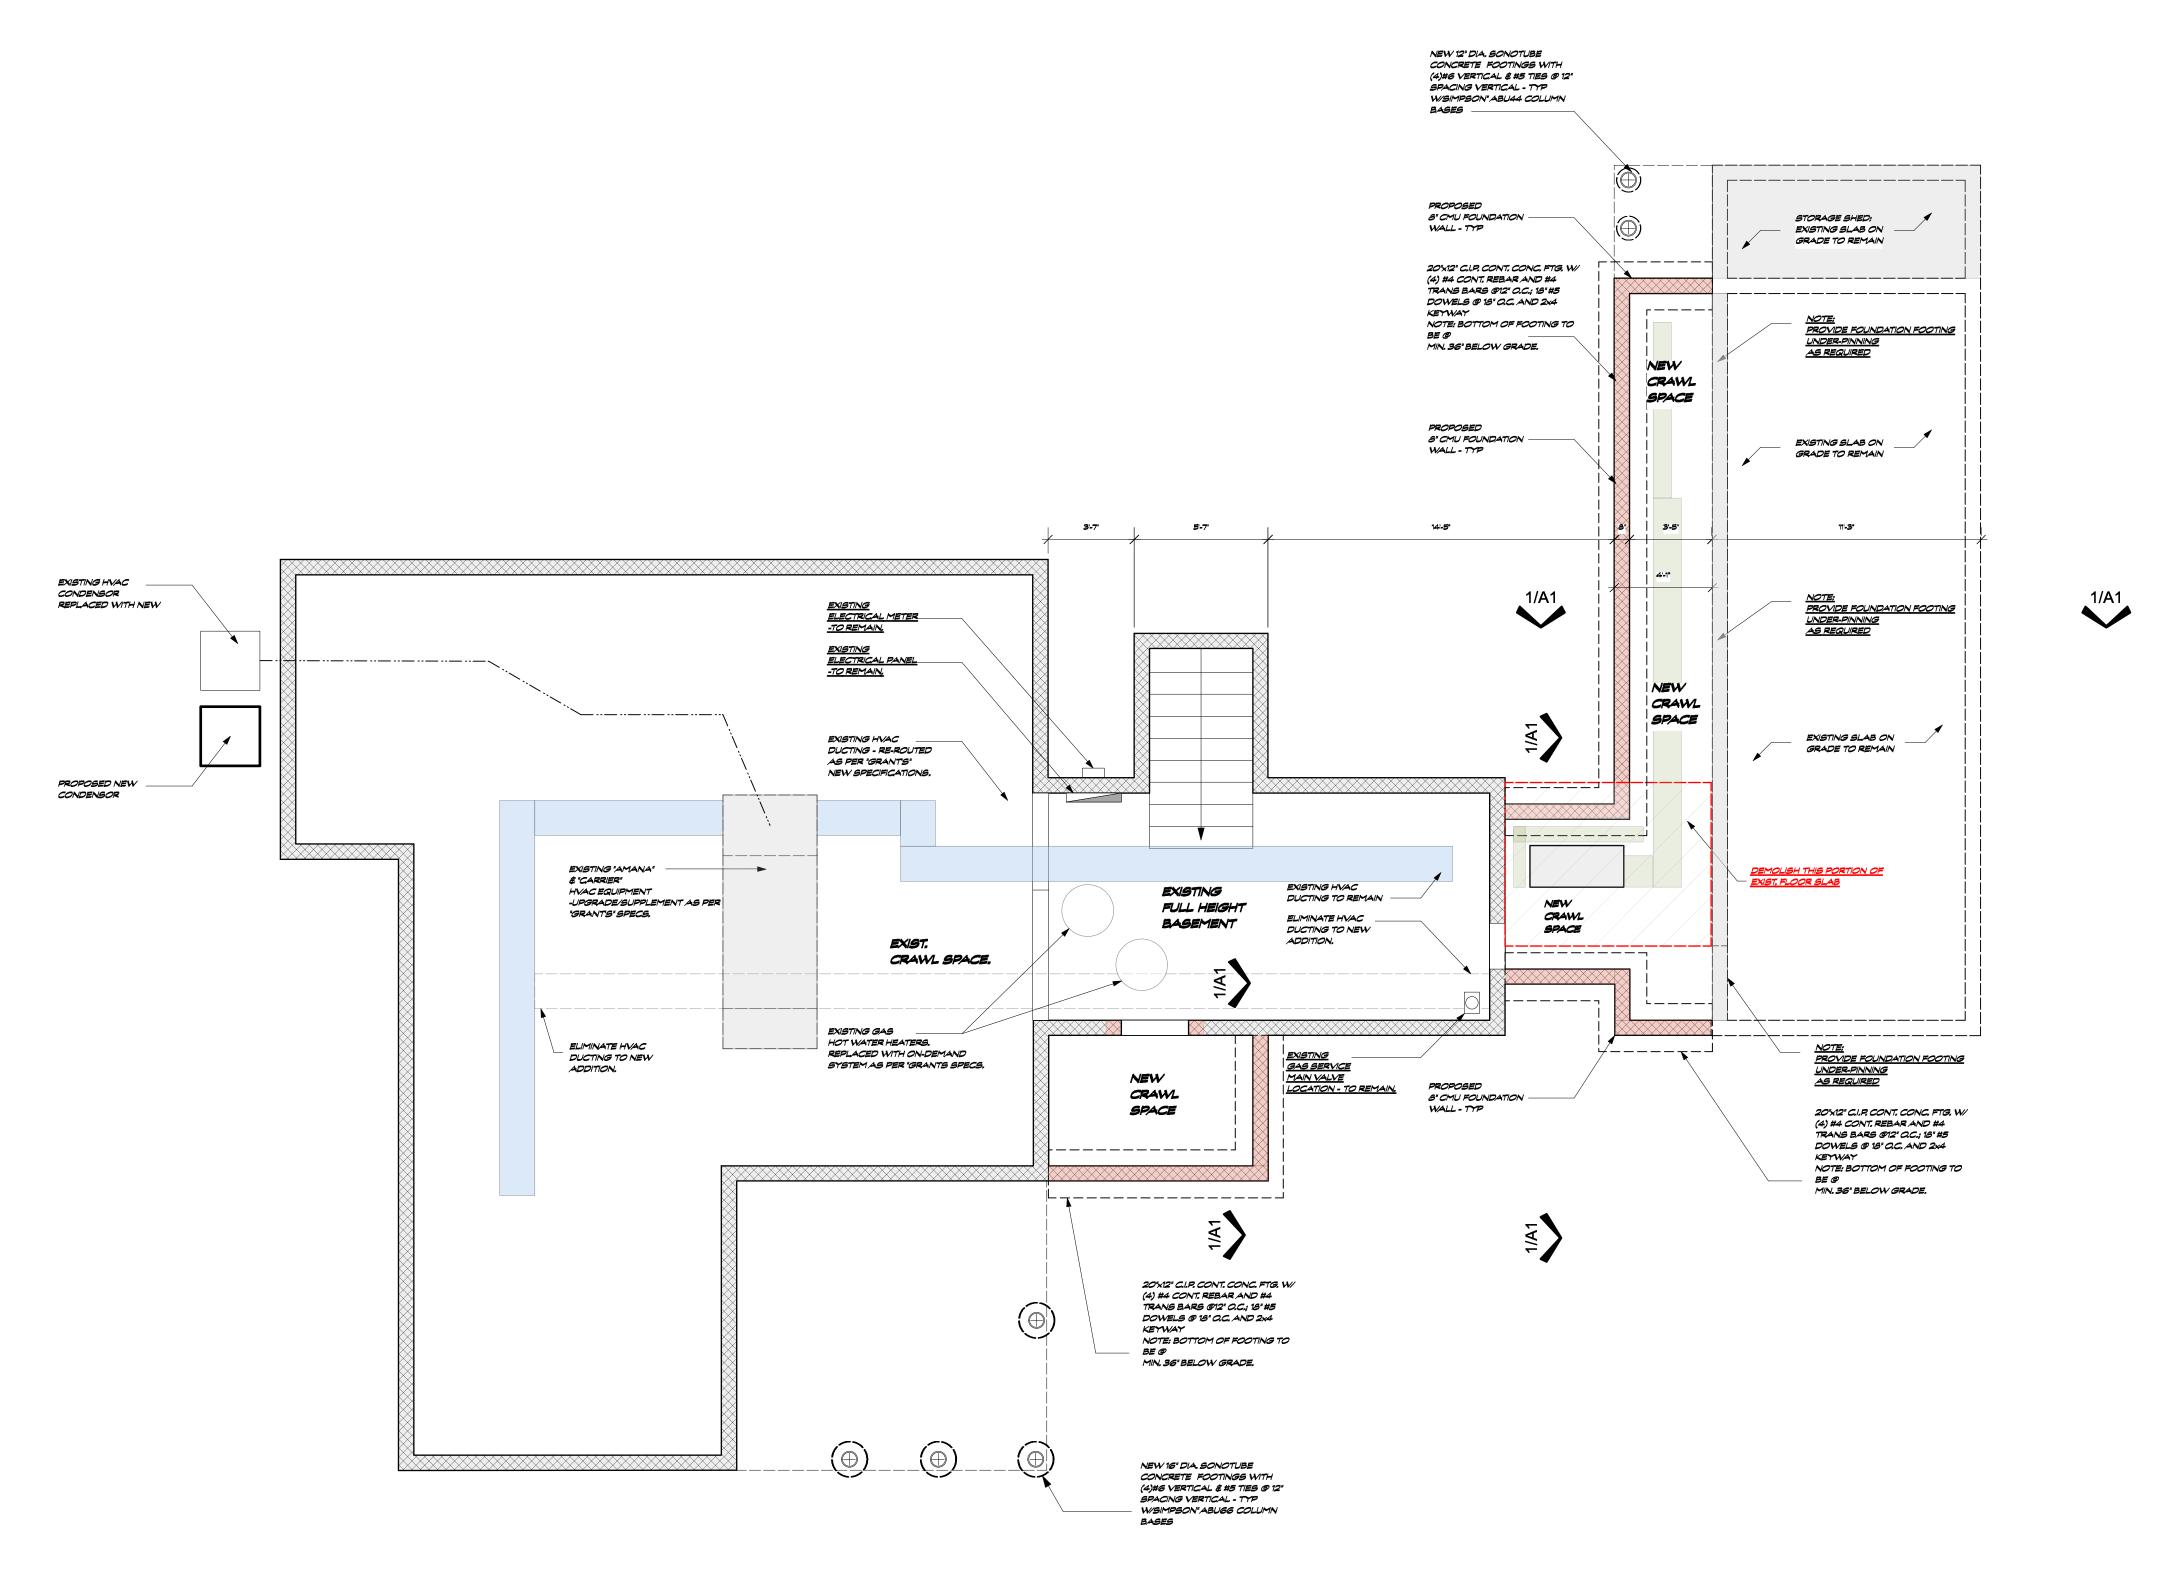

BASEMENT LEVEL - SCALE: 1/4" = 1



P2D1 - Design/Build

P. O. Box 1778 Sag Harbor, NY11963 T: 631-494-5300

COPYRIGHT © P2D1 2013 P2D1 - DESIGN/BUILD LLC retains copyright to all material within this document set, including drawings, research, details, etcetera.

All rights reserved. No part of this document set may be used, reproduced, stored in retrieval system, or transmitted in any form or by any means, electronic, mechanical, photocopying or otherwise, without express written consent of P2D1 - DESIGN/BUILD LLC.


Seal:

Issue Date: Set:

Basement Level Sheet Title Line 2 Sheet Scale

REVISION HISTORY DESCRIPTION DATE APPROVED

> ROOF CONSTRUCTION: 40 YEAR ASPHALT SHINGLES ICE & WATER SHIELD TO 24" INSIDE EXTERIOR WALL IN ACCORDANCE WITH NYS CODE 905.2.7.1 1#2" CDX SHEATHING 2"X 10" ROOF RAFTERS 16" O.C. 1"X6" FASCIA BOARD (PRE PRIMED) CONTINUOUS GUTTERS W/1/8" PITCH PER FOOT (MIN.) PITCH TO DOWN SPOUTS PRE PRIMED WOOD SOFFIT TYP. CONTINUOUS SOFFIT VENT TYP. ROOF INSULATION: (7") "ICYNENE" CLOSED CELL INSULATION. TYP. EXTERIOR WALL CONSTRUCTION: SIDING ON 15 # BLDG. PAPER ON 5/8" PLYWD. SHEATHING ON 2" X 6" WD. STUDS @ 16" O.C. (2) 2" X 6" TOP PLATE 2" X 6" BOTTOM PLATE W/R-21 BATT INSULATION 5/8" DRYWALL TAPED & SANDED CONTRASTING CLADDING MATERIAL TERMITE SHIELD W/ SILL SEALER 2" RIGID INSULATION 8" CMU FOUNDATION WALL (TYP) FOUNDATION WALL WITH BITUMINOUS WATER PROOFING 20"WX10"H POURED CONCRETE FTG W/ (2) #5 BARS W/2"X4"KEYWAY EXISTING 7 BASEMENT/MECHANICAL-FOUNDATION FOOTING (TO REMAIN)

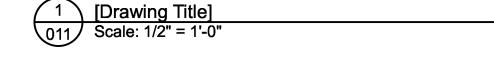

P2D1 - Design/Build


P. O. Box 1778 Sag Harbor, NY11963 T: 631-494-5300


COPYRIGHT © P2D1 2013
P2D1 - DESIGN/BUILD LLC retains copyright to all material within this document set, including drawings, research, within this document set, including drawings, research, details, etcetera.

All rights reserved. No part of this document set may be used, reproduced, stored in retrieval system, or transmitted in any form or by any means, electronic, mechanical, photocopying or otherwise, without express written consent of P2D1 - DESIGN/BUILD LLC.

Issue Date: Set:

Sections-01 Sheet Title Line 2 Sheet Scale

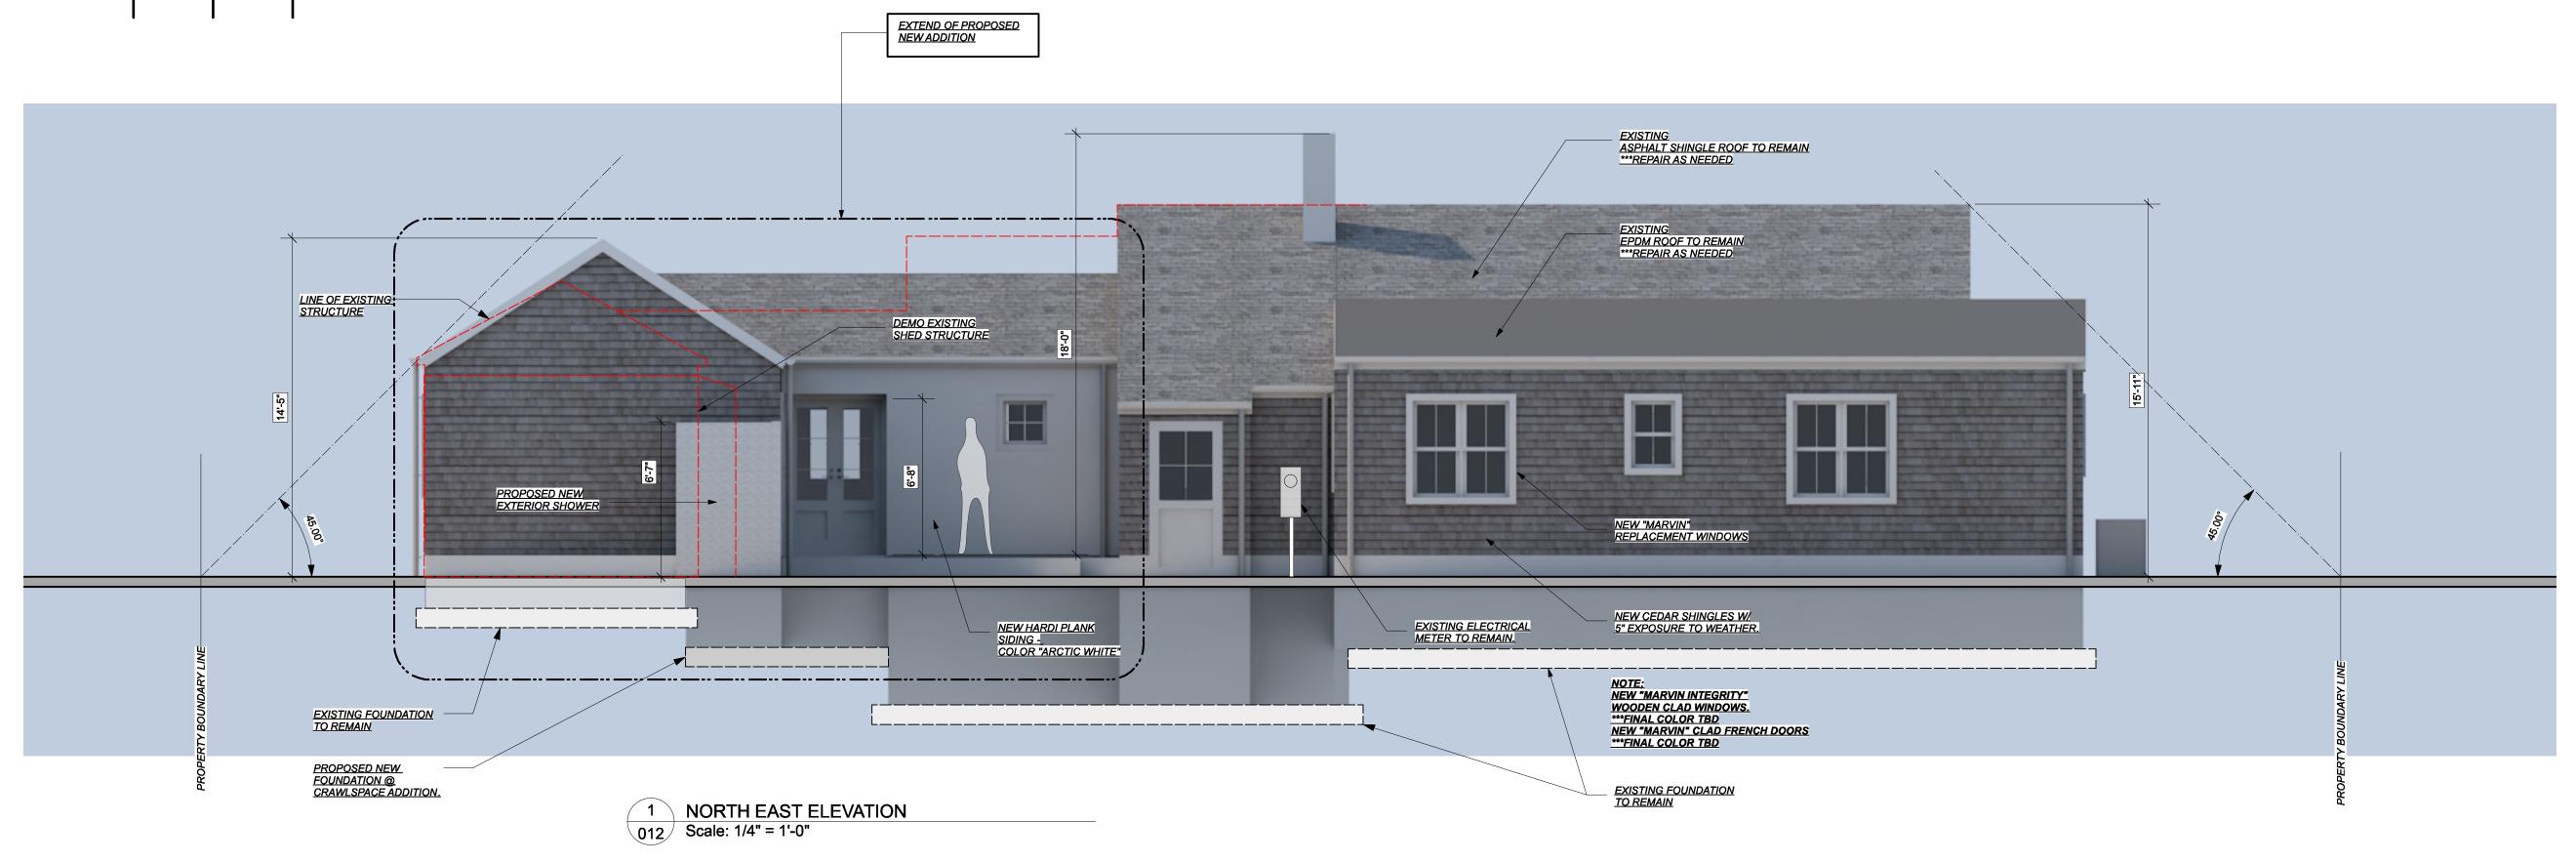

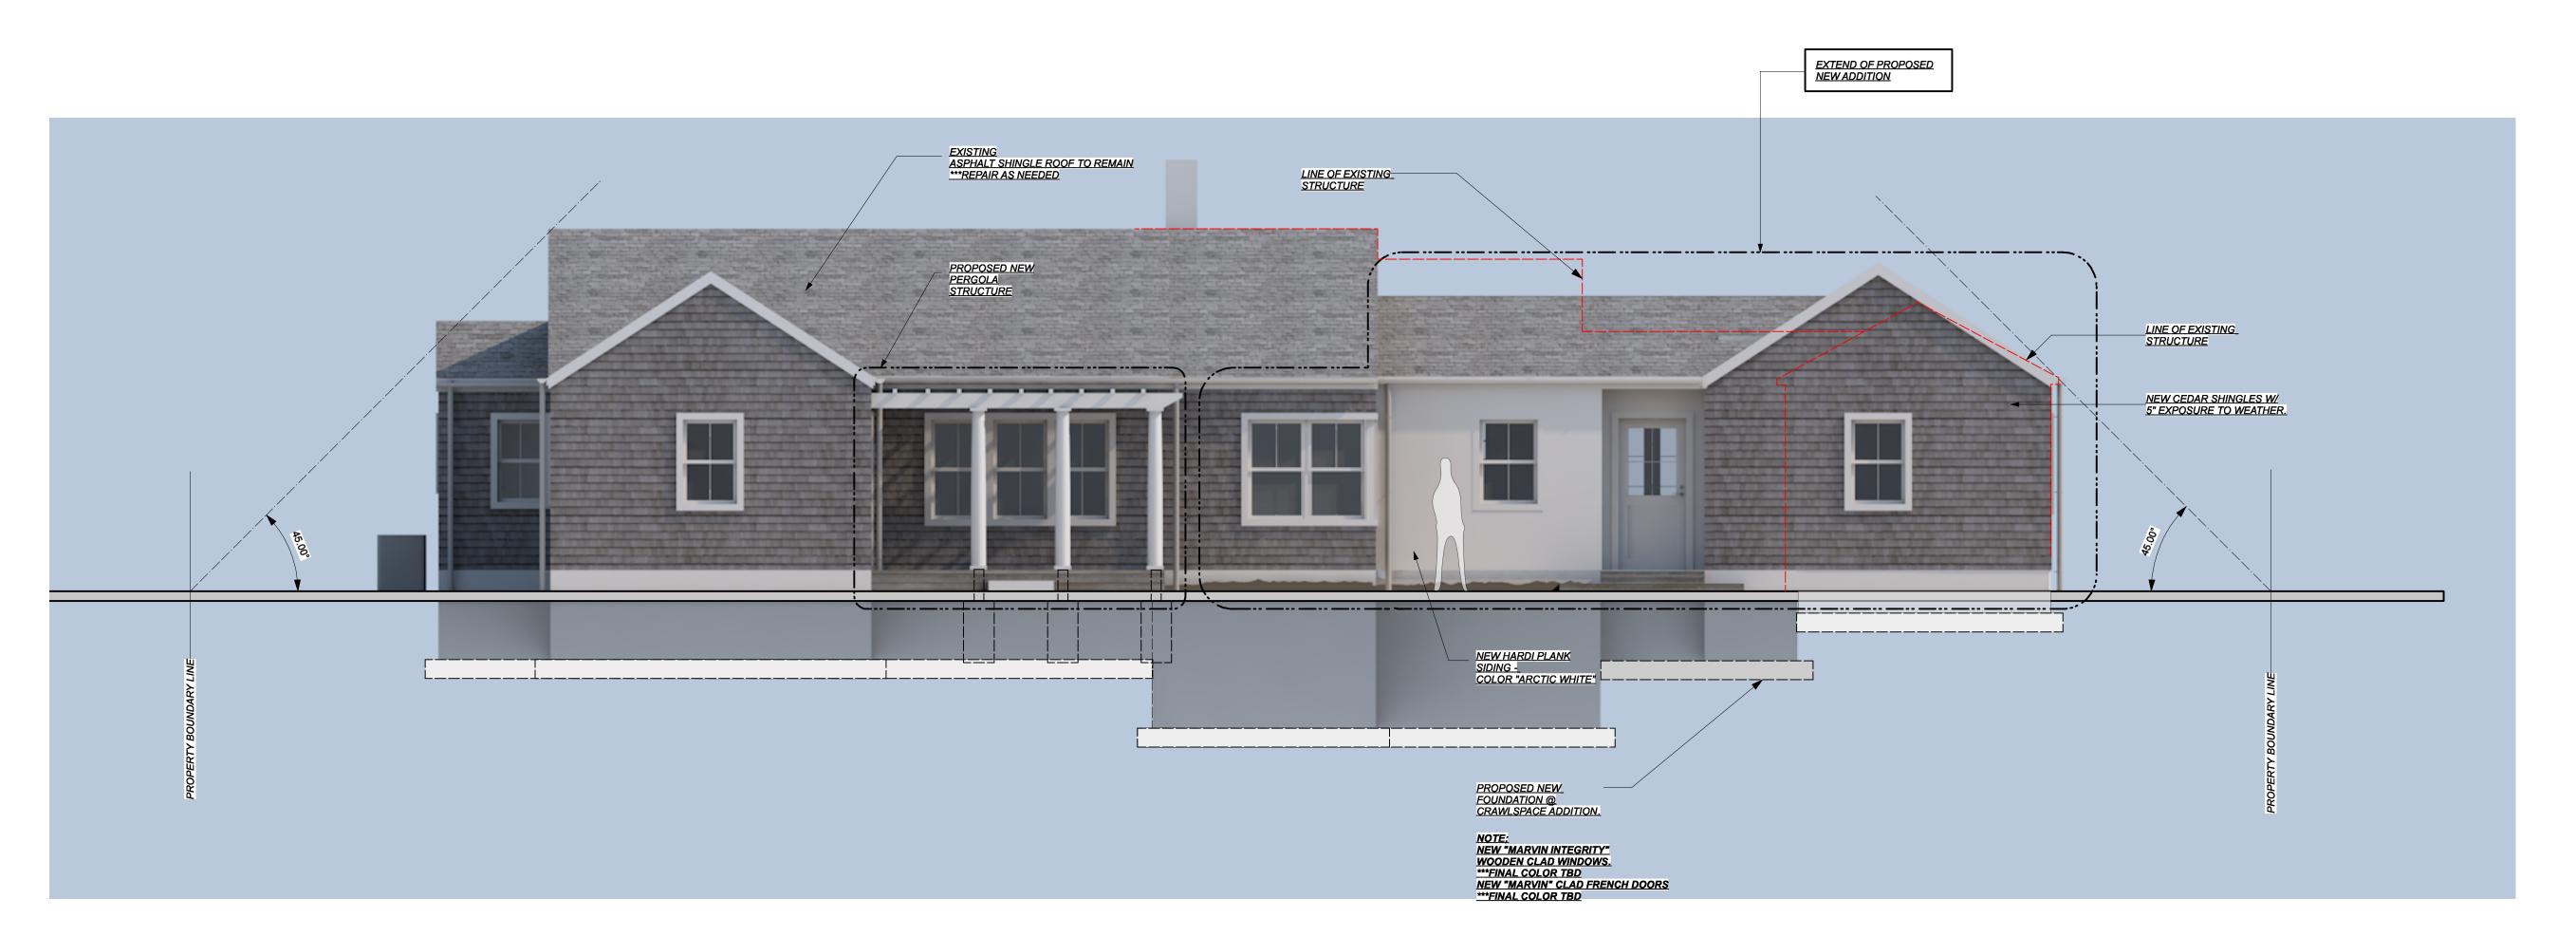

2 SOUTH WEST ELEVATION
012 Scale: 1/4" = 1'-0"

P2D1 - Design/Build P. O. Box 1778

P. O. Box 1778 Sag Harbor, NY11963 T: 631-494-5300

COPYRIGHT © P2D1 2013

P2D1 - DESIGN/BUILD LLC retains copyright to all material within this document set, including drawings, research, details, etcetera.

All rights reserved. No part of this document set may be used, reproduced, stored in retrieval system, or transmitted in any form or by any means, electronic, mechanical, photocopying or otherwise, without express written consent of P2D1 - DESIGN/BUILD LLC.

S

Project: 28 Dayton Lane, East Hampton NY 11937 Pearce Residend

e Date: Sa


Issue Date: Set:

9 JULY 2015


Elevations-01 Sheet Title Line 2 Sheet Scale

REVISION HISTORY

REV DESCRIPTION DATE APPROVED

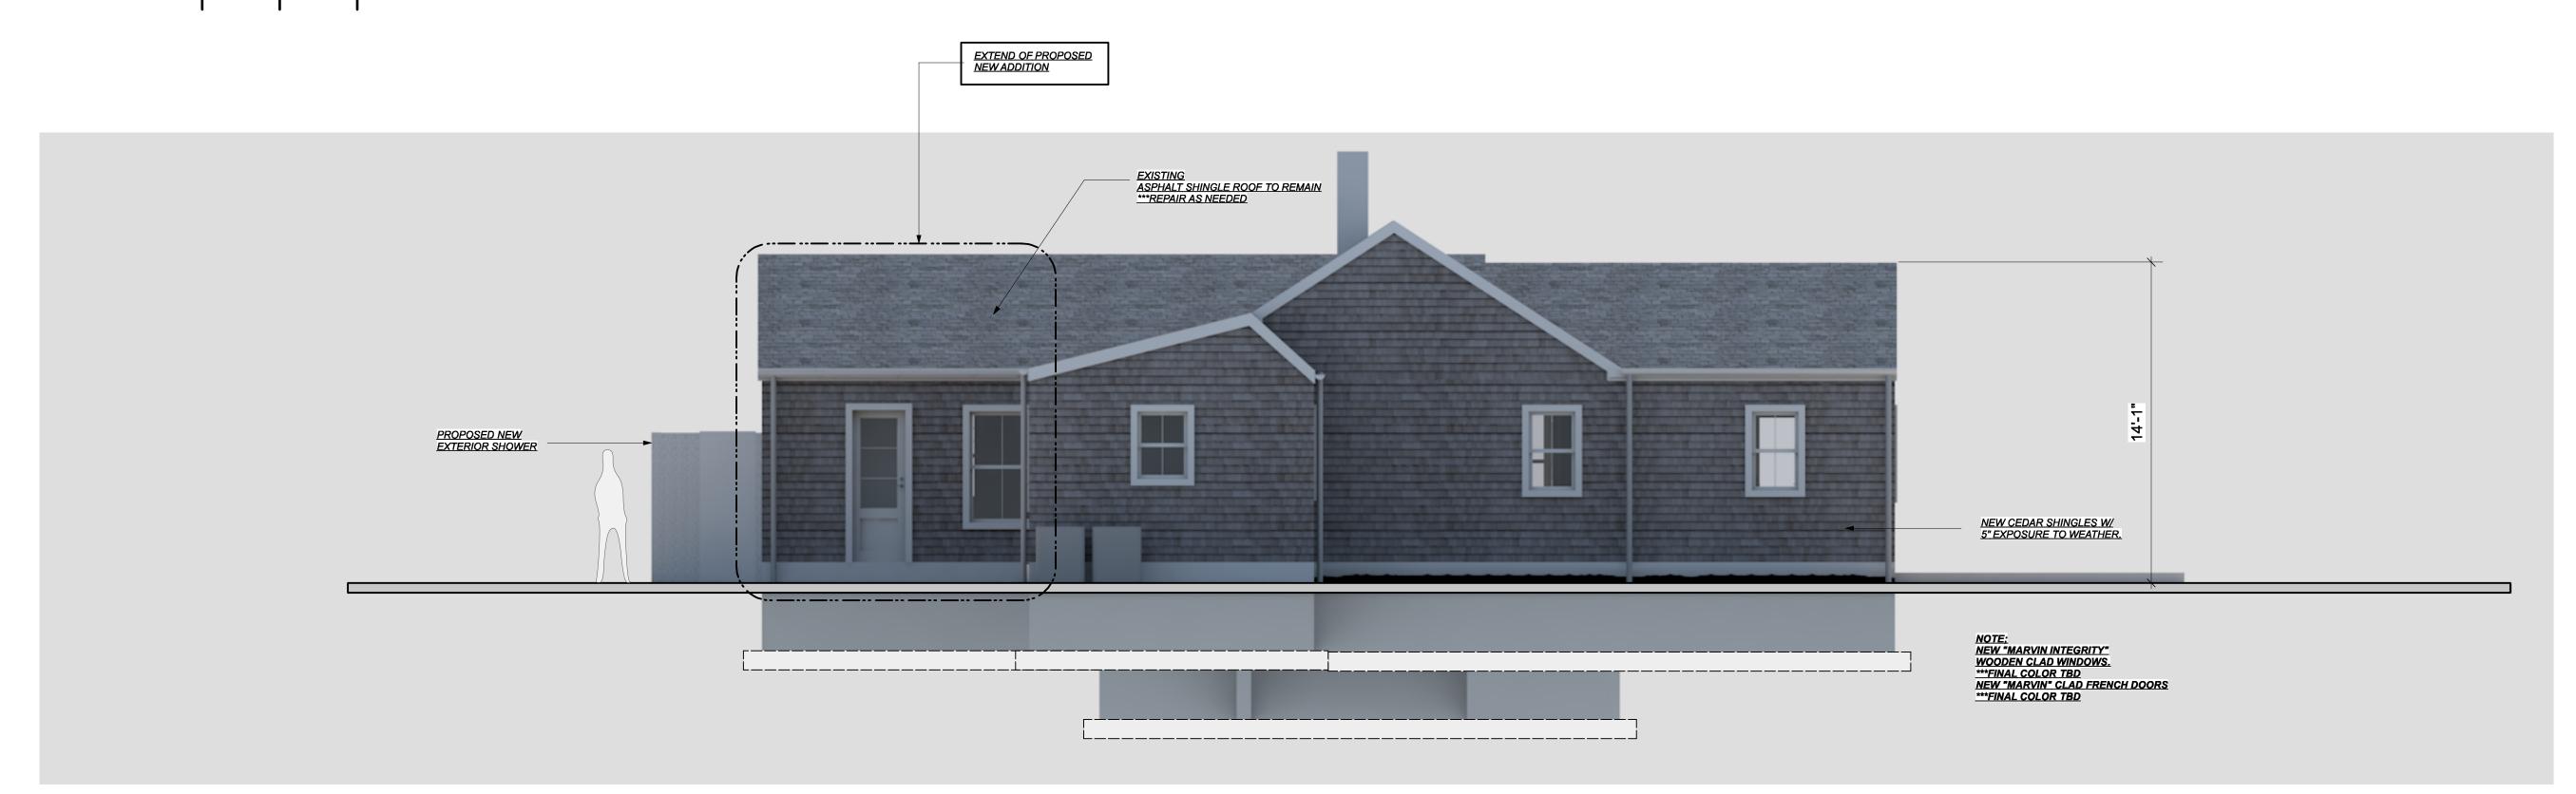

1 NORTH WEST ELEVATION
013 Scale: 1/4" = 1'-0"

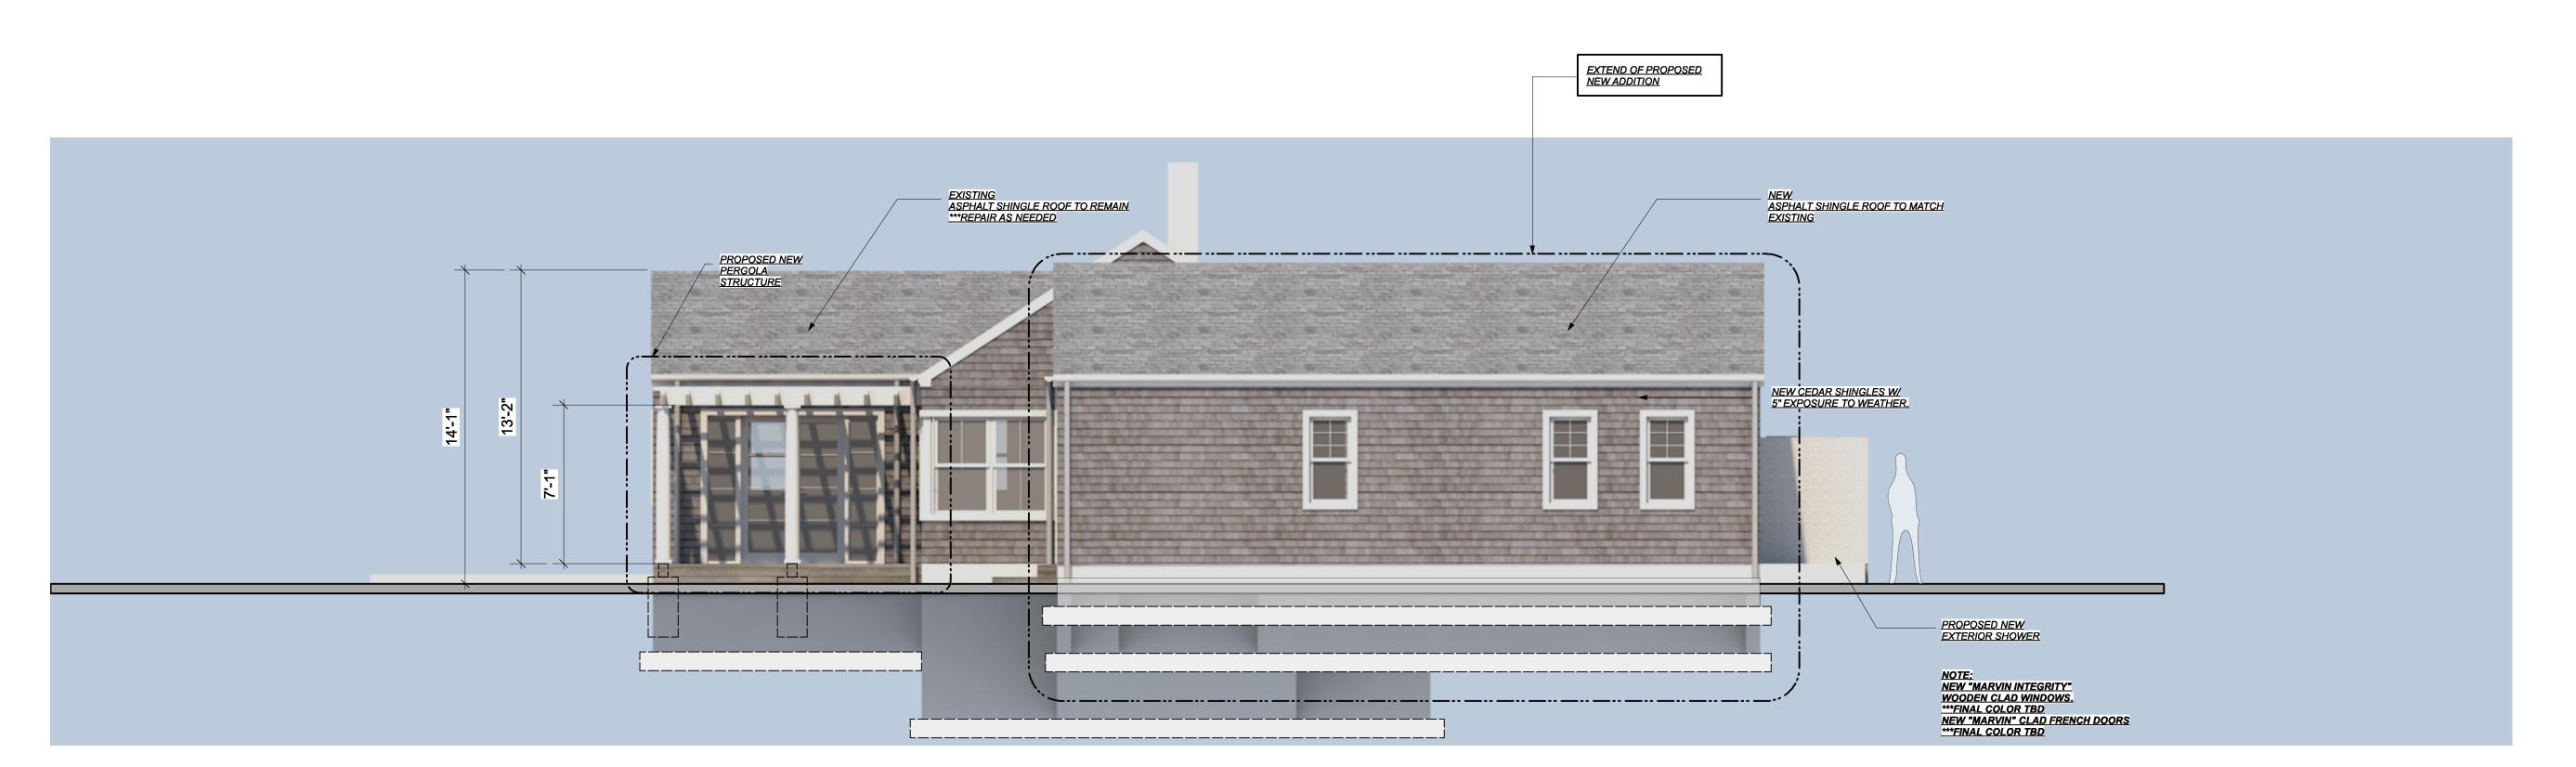

2 SOUTH EAST ELEVATION
013 Scale: 1/4" = 1'-0"

P2D1 - Design/Build
P. O. Box 1778

P. O. Box 1778 Sag Harbor, NY11963 T: 631-494-5300

COPYRIGHT © P2D1 2013
P2D1 - DESIGN/BUILD LLC retains copyright to all material within this document set, including drawings, research, details, etcetera.

All rights reserved. No part of this document set may be used, reproduced, stored in retrieval system, or transmitted in any form or by any means, electronic, mechanical, photocopying or otherwise, without express written consent of P2D1 - DESIGN/BUILD LLC.

S

Project: 28 Dayton Lane, East Hampton NY 11937 Pearce Reside

Issue Date: Set:

Elevations-02 Sheet Title Line 2 Sheet Scale

REVISION HISTORY REV DESCRIPTION DATE APPROVED

	Nominal Size			Window Style			Sill	Shutters	Glass	Frame D	etails			Openings	<b>3</b>	Window D	)ata		
Mark	O.A. Width	O.A. Height	Sash Operation	Shape	Top Shape	Transom Sash Unitin M	attern	Interior		Head Detail Jamb Detail	Sill Detail	Egress Win	RO Width	RO Height	Mas O Width	Mas O Height	Model No.	Accessories	Comments
23 0	64'4"	92'3"		23	23 2	3 -	23 23		0	0	0	0 Y	64'4	<u>4"</u> 92'3"	69'4"	97'4"	0	0	0
01	4'3"	4'3" (	Custom	Rectangle	Square	- Colonial	Timber					FALS	E 4'3	3" 4'3"	4'8"	4'8"			
02	2'0"	]"0'5	Double Hung	Rectangle	Square	- Colonial	Timber					FALS	E 2'0	0" 3'0"	2'0"	3'4"			
03	4'3"	4'3"(	Custom	Rectangle	Square	- Colonial	Timber					FALS	E 4'3	3" 4'3"	4'8"	4'8"			
05	3'0"		Double Hung	Rectangle	Square	- Colonial	Timber					FALS		O" 5'0"	3'4"	5'4"			
06	3'0"		Double Hung	Rectangle		- Colonial	Timber					FALS			3'4"	5'4"			
					Square														
07	3'0"		Double Hung	Rectangle	Square	- Colonial	Timber					FALS			3'4"	5'4"			
08	2'0"		Single Hung	Rectangle	Square	- Colonial	Timber					FALS			2'0"	4'0"			
09	2'0"	4'0"[	Double Hung	Rectangle	Square	- Colonial	Timber					FALS	E 2'0	0" 4'0"	2'0"	4'0"			
10	2'0"	4'0" [	Double Hung	Rectangle	Square	- Colonial	Timber					FALS	E 2'0	0" 4'0"	2'0"	4'0"			
11	2'6"	3'10" [	Double Hung	Rectangle	Square	- Colonial	Timber					FALS	E 2'6	<u>3'10"</u>	2'8"	4'0"			
13	2'8"	3'10" [	Double Hung	Rectangle	Square	- Colonial	Timber					FALS	E 2'8	3'10"	2'8"	4'0"			
14	5'3"	4'6"	Custom	Rectangle	Square	- Colonial	Timber					FALS	E 5'3	3" 4'6"	5'4"	4'8"			
15	5'3"	4'6"	Custom	Rectangle	Square	- Colonial	Timber					FALS	E 5'3	3" 4'6"	5'4"	4'8"			
16	2'6"	4'6" [	Double Hung	Rectangle	Square	- Colonial	Timber					FALS	E 2'6	6" 4'6"	2'8"	4'8"			
17	2'6"	4'6"	Double Hung	Rectangle	Square	- Colonial	Timber					FALS	E 2'6	6" 4'6"	2'8"	4'8"			
18	2'6"	4'6" [	Double Hung	Rectangle	Square	- Colonial	Timber					FALS	E 2'6	6" 4'6"	2'8"	4'8"			
19	2'6"	<u> </u> "01' <u>8</u>	Double Hung	Rectangle	Square	- Colonial	Timber					FALS	E 2'6	<u>6" 3'10"</u>	2'8"	4'0"			
20	2'2"	3'7"[	Double Hung	Rectangle	Square	- Colonial	Timber					FALS	E 2'2	2" 3'7"	2'8"	4'0"			
21	2'2"	3'7"[	Double Hung	Rectangle	Square	- Colonial	Timber					FALS	E 2'2	2" 3'7"	2'8"	4'0"			
22	2'2"		Double Hung	Rectangle	Square	- Colonial	Timber					FALS			2'8"	4'0"			
23	2'4"		Double Hung	Rectangle	Square	- Colonial	Timber					FALS			2'8"	3'4"			
24	2'0"	2.0.1	Awning	Rectangle	Square	- Colonial	Timber					FALS	E 2'0	0" 2'0"	2'0"	2'0"			

P2D1 - Design/Build P. O. Box 1778 Sag Harbor, NY11963 T: 631-494-5300

COPYRIGHT © P2D1 2013

P2D1 - DESIGN/BUILD LLC retains copyright to all material within this document set, including drawings, research, details, etcetera.

All rights reserved. No part of this document set may be used, reproduced, stored in retrieval system, or transmitted in any form or by any means, electronic, mechanical, photocopying or otherwise, without express written consent of P2D1 - DESIGN/BUILD LLC.

st Hampton NY 11937

Issue Date: Set:

Window Schedule Sheet Title Line 2 Sheet Scale

REVISION HISTORY DESCRIPTION DATE APPROVED

EXISTING CONDITIONS/DEMO NOTES:

EXISTING CONDITIONS AND PROPOSED ALTERATIONS HAVE BEEN BASED UPON PHYSICAL INSPECTION AND ASSUMPTION PERTAINING TO AREAS WITH LIMITED ACCESS, NOTIFY ARCHITECT & ENGINEER ONCE DEMOLITION HAS COMMENCED FOR INSPECTION AND MODIFICATION AS REQUIRED.

NEW CONSTRUCTION DATUM:

AGSUME FIRST FLOOR ROUGH ELEVATION @ 00". REFERENCE DATUM ELEVATION TO BE DETERMINED IN FIELD & APPROVED BY ARCHITECT PRIOR TO TRENCHING FOR FOUNDATION FOOTINGS,


NEW FILL/SOIL COMPACTION:

"USE ONLY CLEAN GRANULAR MATERIAL - SAND,

"INDIVIDUAL LIFTS OF MATERIAL NOT TO EXCEED 12" DEEP.

"MINIMUM 95% MECHANICAL COMPACTION. "WET DOWN AREA OF COMPACTION TO ASSIST WITH MECHANICAL COMPACTION - TYP.

\*AVOID FREEZING CONDITIONS.

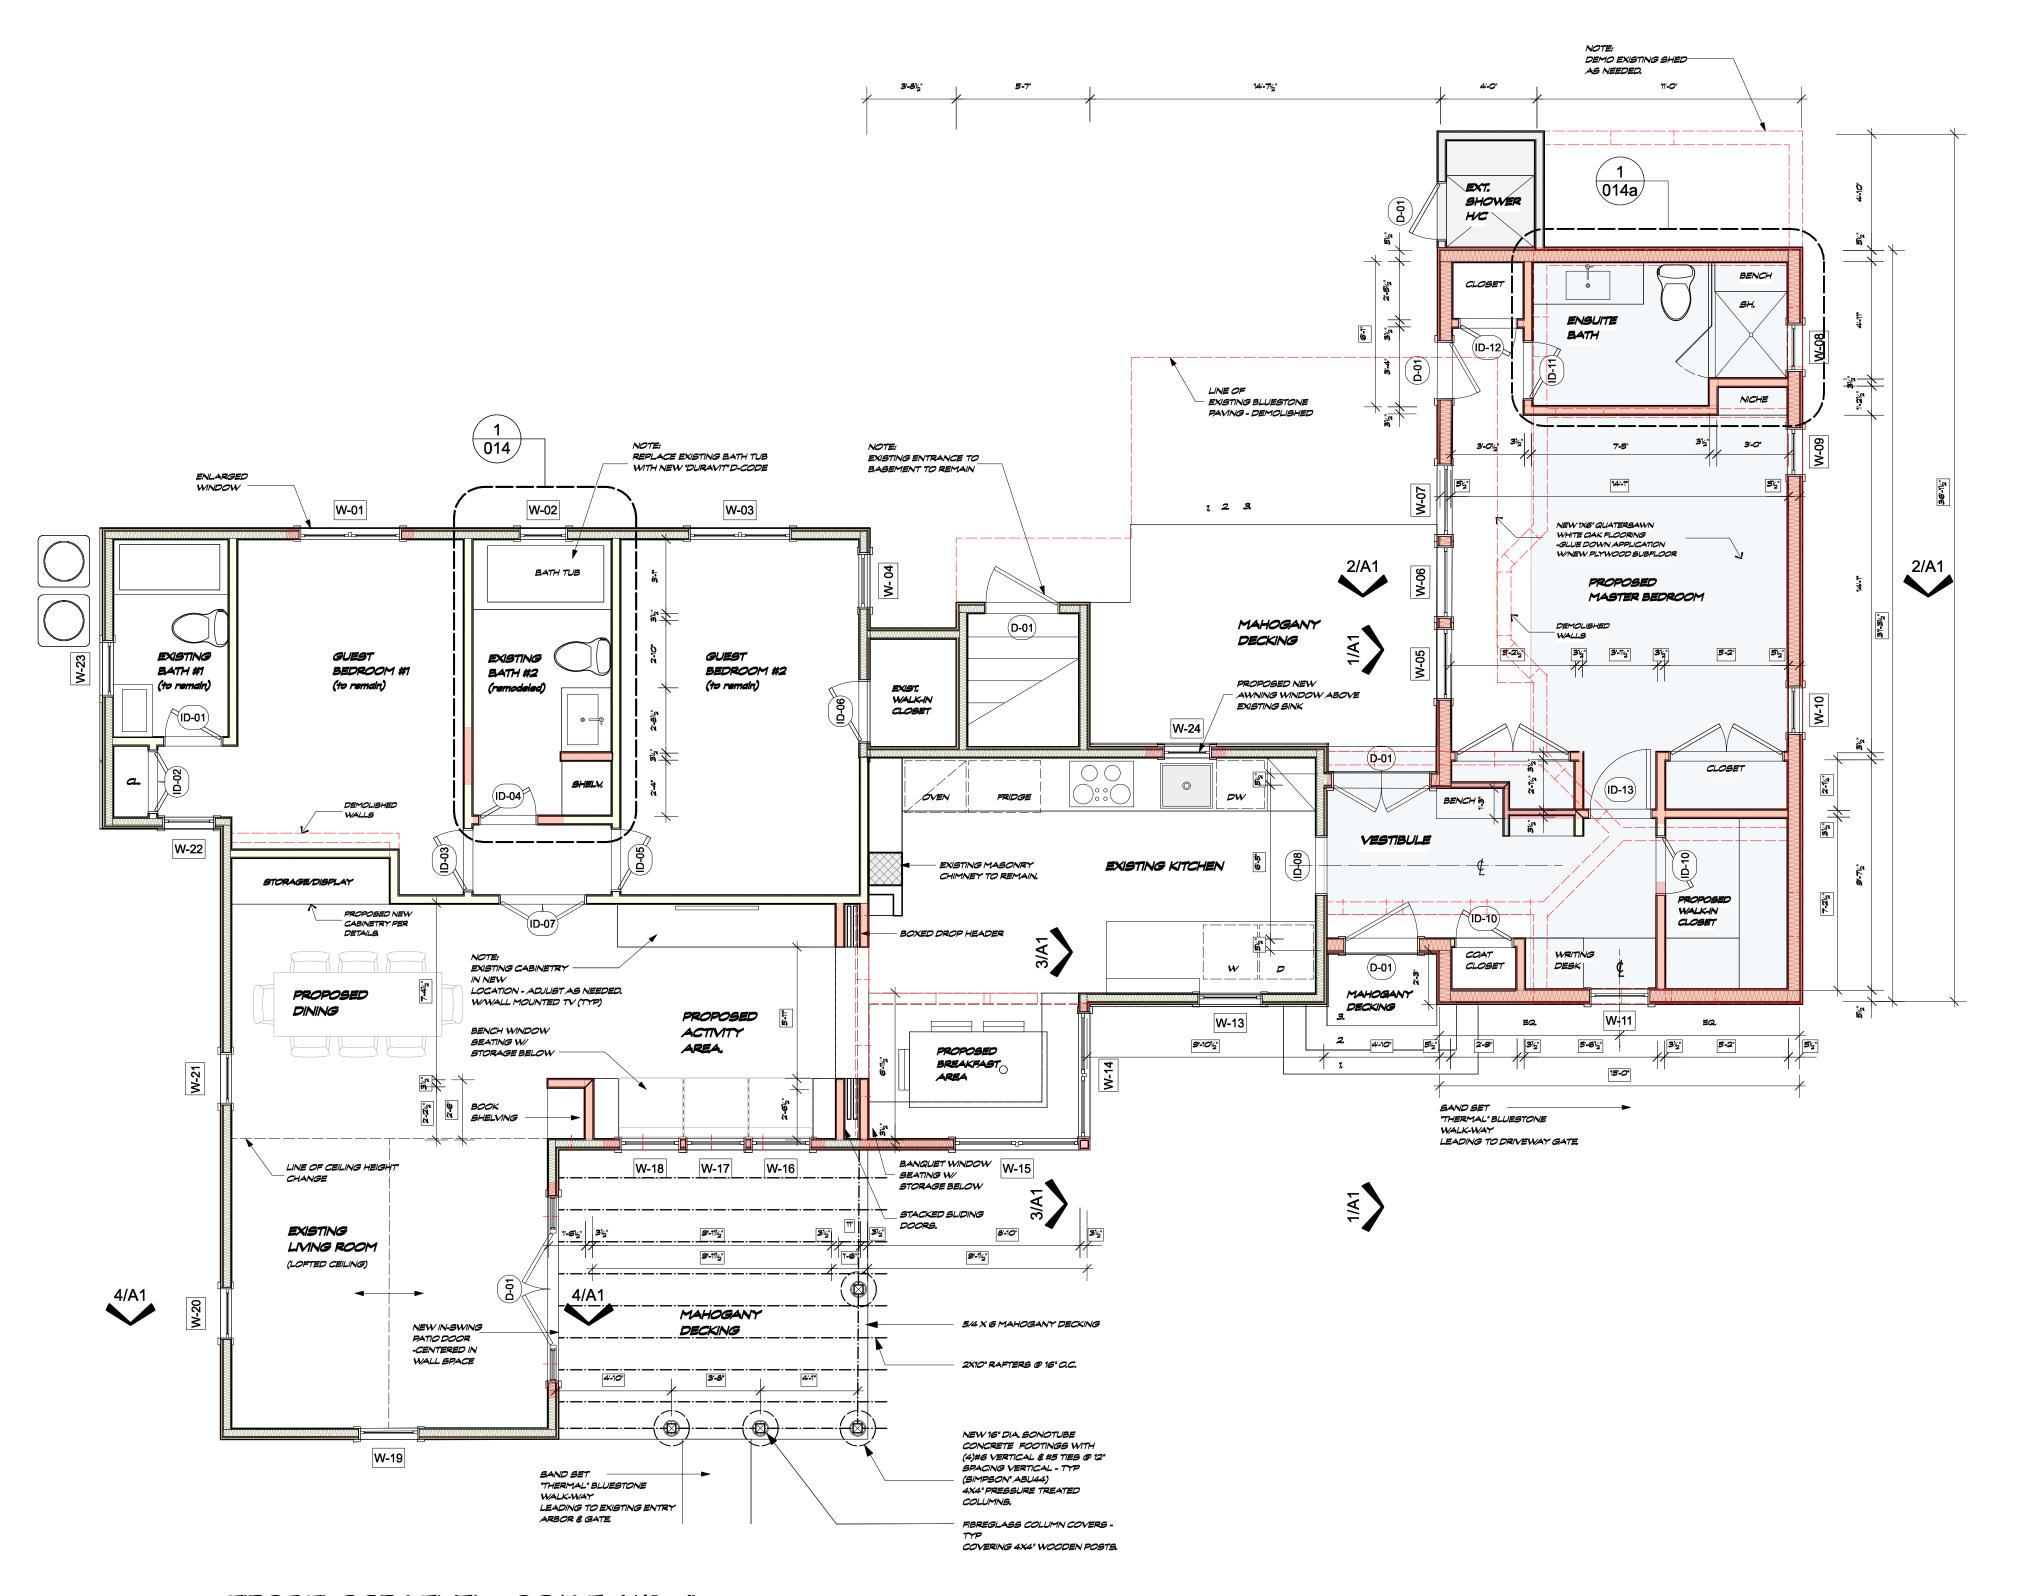

FIRST FLOOR LEVEL - SCALE: 1/4" = 1



P2D1 - Design/Build

P. O. Box 1778 Sag Harbor, NY11963 T: 631-494-5300

COPYRIGHT © P2D1 2013 P2D1 - DESIGN/BUILD LLC retains copyright to all material within this document set, including drawings, research, details, etcetera.

All rights reserved. No part of this document set may be used, reproduced, stored in retrieval system, or transmitted in any form or by any means, electronic, mechanical, photocopying or otherwise, without express written consent of P2D1 - DESIGN/BUILD LLC.

Issue Date: Set:

2 JULY 2015

First Floor Level Sheet Title Line 2 Sheet Scale

	REVISION HISTORY		
REV	DESCRIPTION	DATE	APPROVED

Nominal Size Door Style					Door Frame					Frame De	Fire Rating			Openings			Door Data						
Mark	Width	Height	ss Door Operation	Top Shape	Slab Style	Side Lights	L Sidelt Wid	R Sidelt Wid	Glaz. Style	Jamb Thick	Jamb Depth	Head Detail	Jamb Detail	Sill Detail	Frame	Door Slab	HW Set	RO Width	RO Height	Mas O Width	Mas O Height	Model No.	Accessories
19 0	51'8"	126'8"		19	19 19	9 *	19'4"	19'4"	19	9 1'2 1/4"	8'6 1/8'		0 0	0	0	0	13	57'0 1/2"		60'8"	139'4"	0	0
- 06	2'6"	6'8"	1 3/4" Swing Simple	Square	Solid		N/A	N/A N		3/4"	<u>5 5/8'</u>						DHW-#	2'7 1/2"	6'8 3/4"	2'8"	7'4"		
- 08	2'4"	6'8"	1 3/4" Cased Opening	Square	Glass	*	N/A	N/A N		3/4"	5 5/8'						DHW-#	2'5 1/2"	6'8 3/4"	2'8"	7'4" 7'4"		
)- 01 )- 01	4'8" 2'4"	6'8" 6'8"	1 3/4" Swing Bi-part 1 3/4" Swing Simple	Square	Glass		1'4" N/A	1'4" N N/A N		3/4" 3/4"	5 5/8' 4 3/4'						DHW-# DHW-#	7'9 1/2" 2'5 1/2"	6'8 3/4" 6'8 3/4"	8'0" 2'8"	7'4"		
)- 01 )- 03	2'6"	6'8"	1 3/4   Swing Simple 1 3/4"   Swing Simple	Square Square	Solid Solid		N/A N/A	N/A N		3/4"	4 3/4 4 3/4'						)HW-#	25 1/2 2'7 1/2"	6'8 3/4"	2'8"	7'4"		
)- 05	2'6"	6'8"	1 3/4" Swing Simple	Square	Solid		N/A	N/A N		3/4"	4 3/4 4 3/4'						OHW-#	2'7 1/2"	6'8 3/4"	2'8"	7'4"		
)- 03 )- 07	3'6"	6'8"	1 3/4" Swing Bi-part	Square	Panel		N/A	N/A N		3/4"	4 3/4						DHW-#	3'7 1/2"	6'8 3/4"	4'0"	7'4"		
0- 04	2'4"	6'8"	1 3/4" Swing Simple	Square	Solid		N/A	N/A N		3/4"	4 3/4						DHW-#	2'5 1/2"	6'8 3/4"	2'8"	7'4"		
)- 02	2'6"	6'8"	1 3/4" Swing Bi-part	Square	Solid		N/A	N/A N		3/4"	4 3/4'						DHW-#	2'7 1/2"	6'8 3/4"	2'8"	7'4"		
- 01	4'0"	6'8"	1 3/4" Swing Bi-part	Square	Panel		N/A	N/A N		3/4"	7 5/8'						DHW-#	4'1 1/2"	6'8 3/4"	4'8"	7'4"		
)- 01	3'0"	6'8"	1 3/4" Swing Simple	Square	Panel		N/A	N/A N	lone	3/4"	7 5/8'						DHW-#	3'1 1/2"	6'8 3/4"	3'4"	7'4"		
- 01	2'4"	6'8"	1 3/4" Swing Simple	Square	Panel		N/A	N/A N	lone	3/4"	7 5/8'	"					DHW-#	2'5 1/2"	6'8 3/4"	2'8"	7'4"		
- 10	2'4"	6'8"	1 3/4" Swing Simple	Square	Solid		N/A	N/A N		3/4"	4 3/4'							2'5 1/2"	6'8 3/4"	2'8"	7'4"		
- 11	2'4"	6'8"	1 3/4" Swing Simple	Square	Solid		N/A	N/A N		3/4"	4 3/4							2'5 1/2"	6'8 3/4"	2'8"	7'4"		
- 12	2'4"	6'8"	1 3/4" Swing Simple	Square	Solid		N/A	N/A N		3/4"	4 3/4							2'5 1/2"	6'8 3/4"	2'8"	7'4"		
01	3'0"	6'8"	1 3/4" Swing Simple	Square	Panel		N/A	N/A N		3/4"	5 5/8'		1			[	DHW-#	3'1 1/2"	6'8 3/4"	3'4"	7'4"		
01	2'4"	6'8"	1 3/4" Swing Simple	Square	Solid		N/A	N/A N		3/4"	4 3/4							2'5 1/2"	6'8 3/4"	2'8"	7'4"		
- 13	2'6"	6'8"	1 3/4" Swing Simple	Square	Solid		N/A	N/A N		3/4"	4 1/2							2'7 1/2"	6'8 3/4"	2'8"	7'4"		
10	2'4"	6'8"	1 3/4" Swing Simple	Square	Solid		N/A	N/A N	lone	3/4"	4 3/4	."						2'5 1/2"	6'8 3/4"	2'8"	7'4"		

P2D1 - Design/Build P. O. Box 1778

P. O. Box 1778
Sag Harbor, NY11963
T: 631-494-5300

COPYRIGHT © P2D1 2013
P2D1 - DESIGN/BUILD LLC retains copyright to all material within this document set, including drawings, research, details, etcetera.

All rights reserved. No part of this document set may be used, reproduced, stored in retrieval system, or transmitted in any form or by any means, electronic, mechanical, photocopying or otherwise, without express written consent of P2D1 - DESIGN/BUILD LLC.

Sea

roject: 28 Dayton Lane, East Hampton NY 11937 Pearce Residen

Issue Date: Set:


Door Schedule Sheet Title Line 2 Sheet Scale

## **ELECTRICAL NOTES - GENERAL**

- 1. LAYOUT AND MARK ALL ELECTRICAL DEVICES (LIGHT FIXTURES, SWITCHES, RECEPTACLES, ETC.) BEFORE SETTING ANY ELECTRICAL BOXES OR RUNNING OF ANY WIRING. GENERAL CONTRACTOR TO SCHEDULE WALK THROUGH AND REVIEW WITH OWNER, FOR OWNERS APPROVAL, BEFORE PROCEEDING. WALK THROUGH TO INCLUDE LOCATING SPECIAL WIRING INCLUDING, PHONE JACKS, DATA-CAT6, T.V. HOOK-UPS, AND STEREO AND ALARM WIRING.
- 2. PROVIDE ALL POWER AND LIGHTING CIRCUITS AS REQUIRED BY CODE AND PROVIDE AN ACCURATE LABELED PANEL BOXE(S) AT COMPLETION OF PROJECT.
- 3. CONTRACTOR TO BE RESPONSIBLE FOR ALL ELECTRICAL WORK. CONTRACTOR TO SUPPLY TEMPORARY DROP POLE FOR CONSTRUCTION, IF NECESSARY.
- 4. G.F.I. CIRCUITS TO BE USED IN BATHROOMS AND KITCHEN AND OTHER LOCATIONS REQUIRED BY GOVERNING CODES OR AS INDICATED ON ELECTRICAL PLAN.
- 5. PROVIDE LINE VOLTAGE SMOKE DETECTORS AS REQUIRED BY CODE.
- 6. TYPICAL SWITCH LOCATION 1'-0" FROM OPENING WHEREVER POSSIBLE, TYPICAL SWITCH HEIGHTS AT 48" TO CENTER UNLESS NOTED OTHERWISE. VERIFY AREAS TO BE DIMMED.

## CONT.

- 7. TYPICAL DUPLEX POWER OUTLETS LOCATION HORIZONTALLY CENTERED IN BASEBOARD
- 8. THERMOSTAT AND SPECIAL CONTROL DEVICES HEIGHTS AT 60" TO CENTER.
- 9. TELEPHONE PROVIDE 4 PAIR WIRING TO EACH JACK LOCATION, HOME RUN TO PHONE PANEL. (LOCATION TO BE DETERMINED WITH OWNER) FOR CONNECTION TO TELEPHONE COMPANY SERVICE.
- 11. THE ELECTRICAL DRAWINGS SHOW SPECIAL SWITCHING, POWER AND LIGHTING ONLY. MINIMUM ELECTRICAL PROVISIONS REQUIRED BY CODE AND REGULATION SHALL BE BY THE CONTRACTOR. VERIFY LOCATION OF SWITCHES AND RECEPTACLES WITH OWNER PRIOR TO INSTALLATION. TELEPHONE, DATA, AND CABLE TV OUTLETS SHALL BE ADJUSTED AS DIRECTED BY OWNER, BUT MUST COMPLY TO ALL CODES

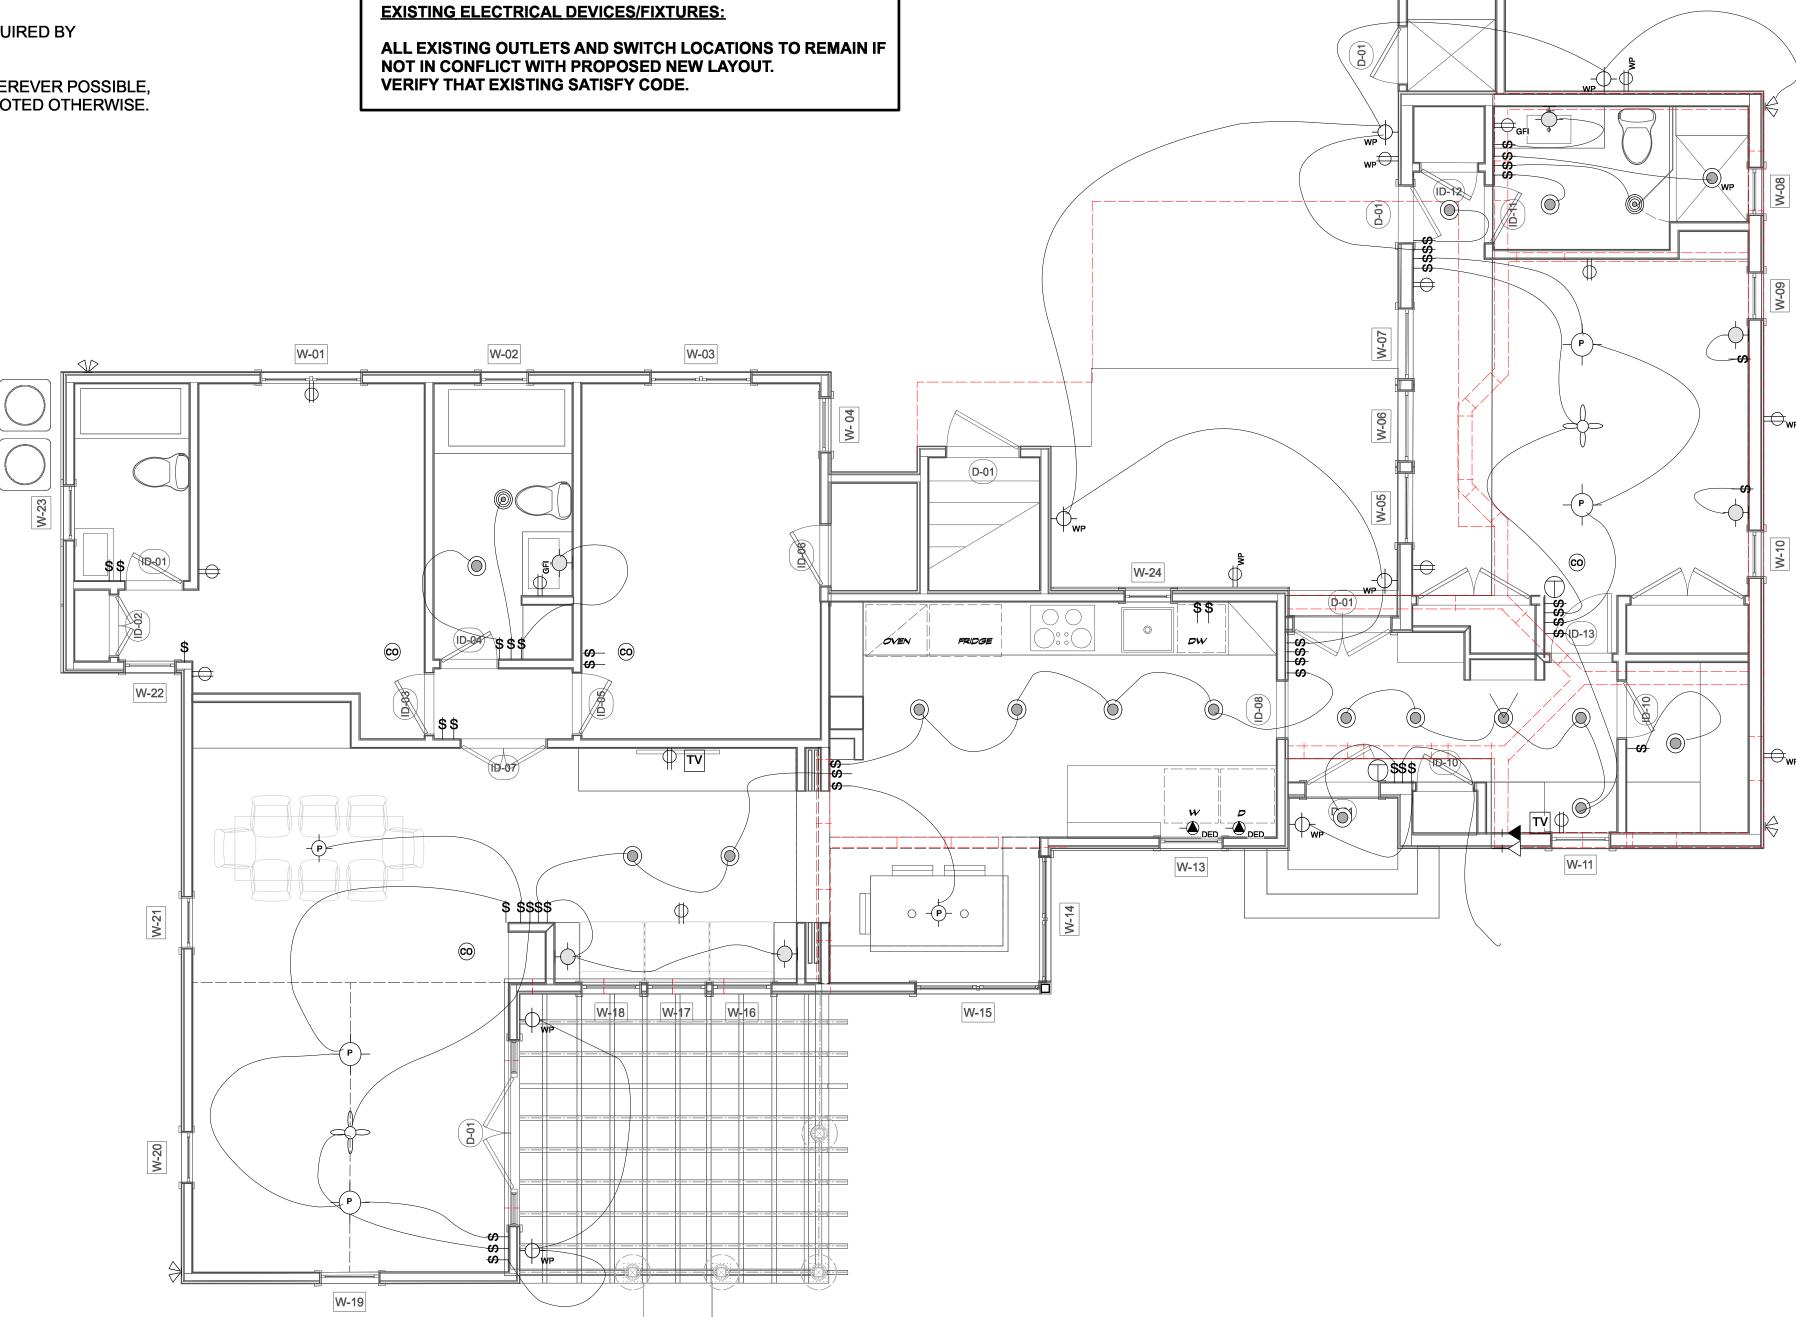

FIRST FLOOR LEVEL - SCALE: 1/4" = 1' ELECTRICAL LAYOUT



Audio/Visual: B# -Basement speaker units F# -First floor speaker units S# -Second floor speaker units SS -Surround sound

IPD-lpod dock

Security:	
K - Alarm keypad	
M.D - Motion detector (wall )	
M.D - Motion detector (ceiling)	
D.C Door contact	
H.D Heat detector (ceiling)	

Hvac	);
	LINEAR GRILL COVER
	6x10" HVAC VENT COVER

	Electric Legend:
\$	Single Pole Switch
\$	Multiple Pole Switch
\$3	Three Way Switch
\$ <sub>JS</sub>	Door Jamb Switch
$\Rightarrow$	Duplex Receptacle Outlet
$\Rightarrow$	Duplex Receptacle Outlet -Split Wired
<del></del>	Duplex Receptacle Outlet -Switch outlet
GFI	GFI Duplex Receptacle Outlet
⊕ <sub>WP</sub>	Weatherproof Duplex Receptacle Outlet
DED DED	Appliance Receptacle Outlet
$\ominus$	Floor Mounted Duplex Outlet
	Floor Mounted Phone Jack
	Floor Mounted Data Jack
TV	Floor Mounted Coaxial Cable (TV)
	(Type 1) Recessed Ceiling Fixture
	(Type 1) Recessed Ceiling Fixture Shielded Directional
O <sub>WP</sub>	(Type 5) Recessed Waterproof Ceiling Fixture
⊕ <sub>WP</sub>	(Type 5) Recessed Ceiling Exterior Fixture
<u></u>	(Type 7) Exhaust Fan W/ Light
	(Type 3) Waterproof Wall Mounted Fixture
<del> </del>	(Type 8)Wall Mounted Washlight Fixture
-(P)-	Surface Mounted Pendant Fixture
<del></del>	Wall Mounted Interior Fixture
<u></u>	Surface Mounted Ceiling Fixture
$\Diamond$	Flood Light
]	(TYPE 9)Surface Mounted Flourescent Light
	Under Cabinet Light
+<	Telephone Jack
<b>→</b>	Data Jack
-[TV]	TV Jack
HJ	AV Controls
$\bigcirc$	Thermostat
FAN	Exhaust Fan
<b>\rightarrow</b>	Ceiling Fan
<u>co</u>	Carbon Monoxide Detector
SP	Ceiling Mounted Speaker
SP	Wall/Cabinet Mounted Speaker
$\bigcirc$	Central Vacuum
	Cove Lighting

P2D1 - Design/Build

P. O. Box 1778 Sag Harbor, NY11963 T: 631-494-5300

COPYRIGHT © P2D1 2013 P2D1 - DESIGN/BUILD LLC retains copyright to all material within this document set, including drawings, research, details, etcetera.

All rights reserved. No part of this document set may be used, reproduced, stored in retrieval system, or transmitted in any form or by any means, electronic, mechanical, photocopying or otherwise, without express written consent of P2D1 - DESIGN/BUILD LLC.

Issue Date: Set:

First Floor Level - ELEC Sheet Title Line 2 Sheet Scale